




### LEGEND

- PROPOSED STORMWATER PIT
- PROPOSED STORMWATER PIPES
- PROPOSED KERB ONLY
- PROPOSED SAWN JOINT
- PROPOSED EXPANSION JOINT
- PROPOSED SLAB THICKNESS
- PROPOSED AREA OF NEW CONCRETE PAVEMENT
- PROPOSED SUB SOIL DRAIN
- PROPOSED HIGH POINT
- PROPOSED CLEAN OUT
- GRATED DRAIN
- SILT FENCE/HAYBALE
- SILT TRAP/SAND BAGS

**NOTE:**  
THIS LAYOUT PRESENTS ONE OF A NUMBER OF POSSIBLE SOLUTIONS FOR THE EROSION AND SEDIMENTATION CONTROL ON THE SITE DURING THE CONSTRUCTION PERIOD. FINAL LAYOUT TO BE PREPARED BY THE CONTRACTOR TO SUIT THEIR SITE LAYOUT, OPERATIONS SEQUENCE, STAGING ETC. ALL CONTROLS TO BE CONSTRUCTED ACCORDING TO THE REQUIREMENTS OF "MANAGING URBAN STORMWATER SOILS AND CONSTRUCTION" - 4TH EDITION LANDCOM, MARCH 2004.

**NOTE:**  
SITE ACCESS AND STOCKPILE LOCATION MAY CHANGE DEPENDING ON CONSTRUCTION PREFERENCE

**SEDIMENT AND EROSION CONTROL PLAN**  
SCALE 1:100

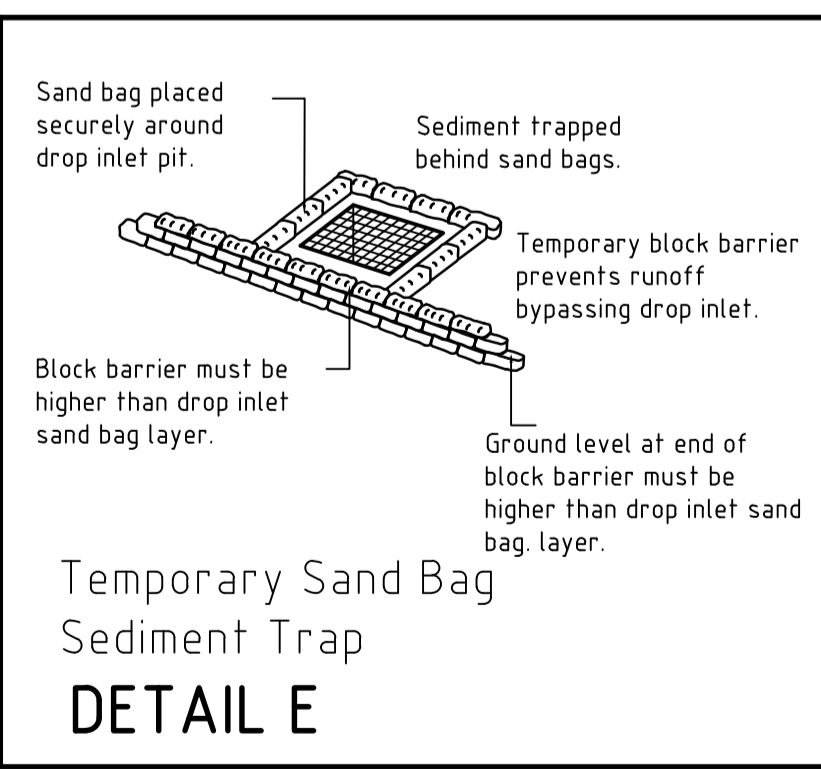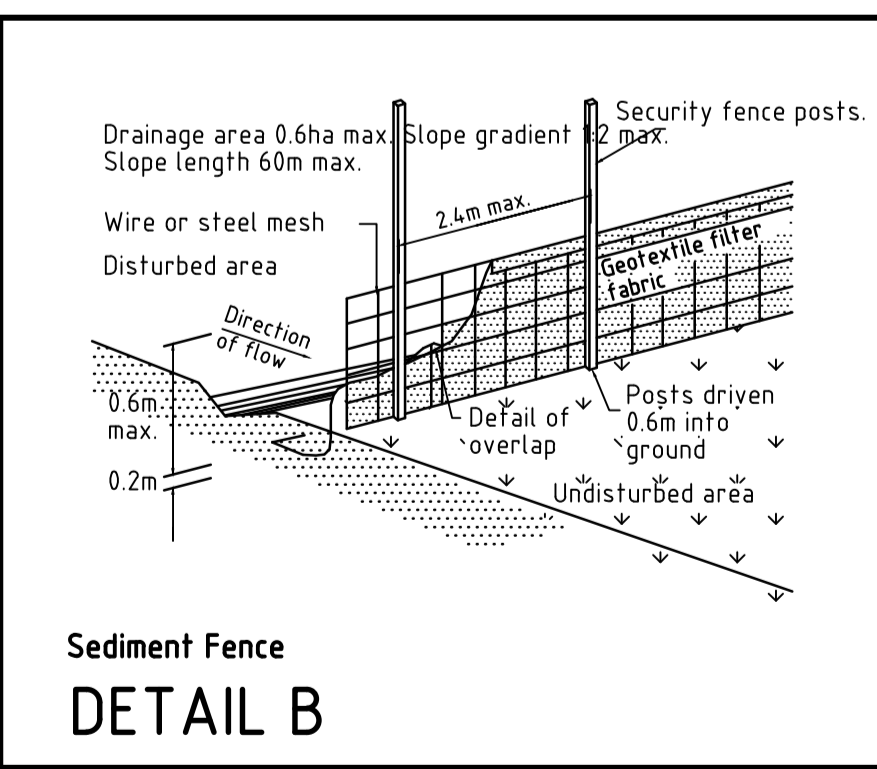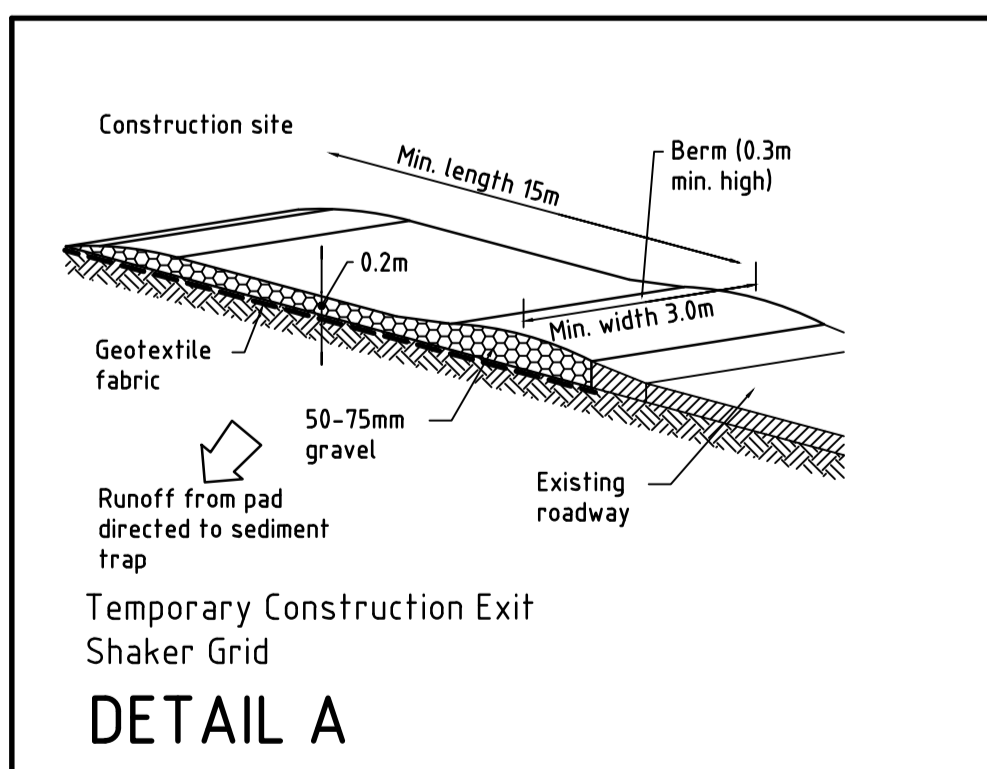

### SEDIMENT RUN-OFF CONTROL NOTES



SR1. THE CONTRACTOR SHALL INSTALL AND MAINTAIN SOIL EROSION AND SEDIMENT CONTROL MEASURES GENERALLY IN ACCORDANCE WITH GUIDELINES OF THE LANDCOM MANAGING URBAN STORMWATER MANUAL AND AS NECESSARY TO PREVENT RUN-OFF FROM SITE OF SEDIMENT RESULTING FROM THE WORKS. SUCH MEASURES SHALL ALSO COMPLY WITH REQUIREMENTS OF COUNCIL AND EPA. THIS WORK SHALL BE DONE PRIOR TO ANY EARTHWORKS COMMENCING ON SITE.

SR2. GRADE FINISHED SURFACE TO SHED WATER EVENLY WITHOUT CHANNELLING (UNTIL PIPED STORMWATER SYSTEM IS CONSTRUCTED). NOMINAL GRADIENTS FROM HIGH POINT OF 0.2%.

SR3. MAINTAIN THE EROSION CONTROL DEVICES INDICATED ON THE DRAWINGS TO THE SATISFACTION OF THE SITE SUPERINTENDENT AND THE LOCAL AUTHORITIES.

SR4. WHEN PROPOSED STORMWATER PITS ARE CONSTRUCTED, PREVENT SITE RUNOFF ENTERING UNLESS SILT FENCES ARE ERECTED AROUND PITS AND ON ROAD.

SR5. STREET PROTECTION WITH SHAKER EXIT GRIDS & STREET PIT INLET PROTECTION TO BE MAINTAINED FOR THE DURATION OF THE CONTRACT.

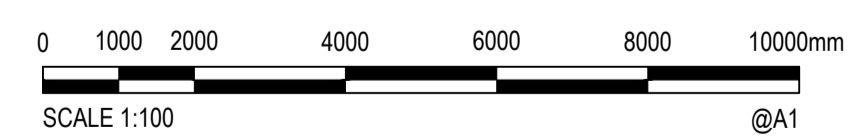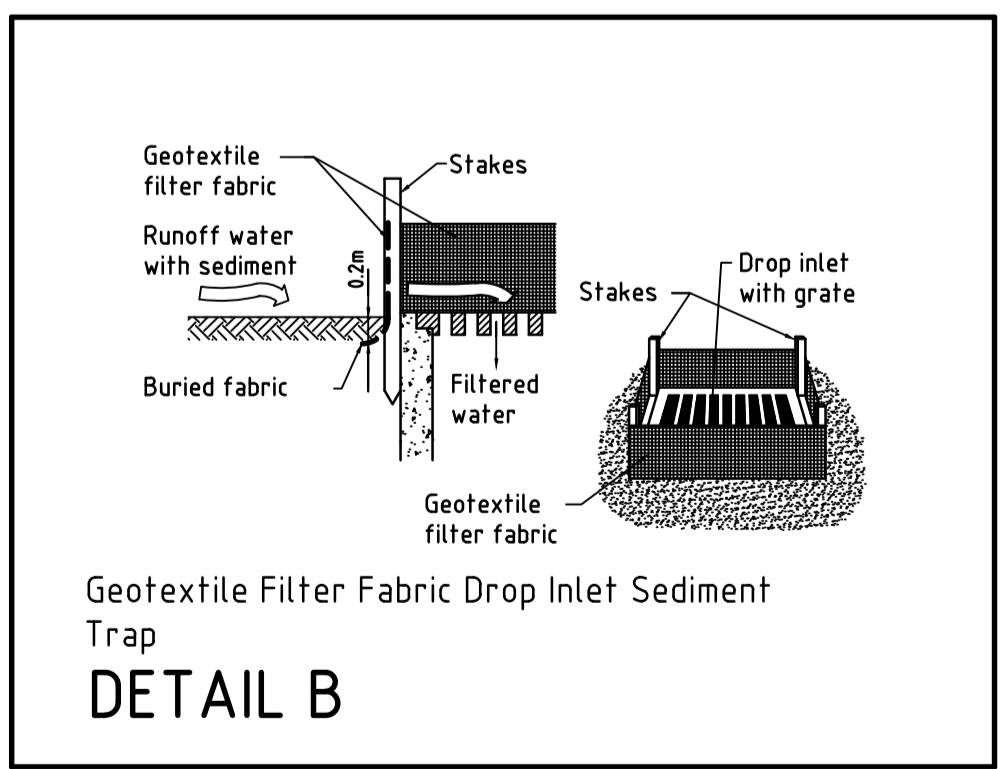

Rev.	Date	Description	Des.	Verif.	Appd.
4	18/03/2016	REVISED CC ISSUE	AC	TY	TY
3	16/03/2016	CC ISSUE	AC	TY	TY
2	26/10/2015	TENDER ISSUE	LPD	TY	TY
1	21/09/2015	CONSTRUCTION CERTIFICATE ISSUE	LPD	TY	TY

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Drawn	LPD	Date	SEP. 2015
Checked	TY	Date	
Designed	TY	Date	
Verified	TY	Date	
Approved		Date	

Client	BRIARS SPORTING CLUB
Project	COMMUNITY AND AMENITIES BUILDING ROTHWELL PARK CONCORD
Title	SEDIMENT AND EROSION CONTROL PLAN AND DETAILS

Status	FOR APPROVAL
NOT TO BE USED FOR CONSTRUCTION PURPOSES	
Scale	1:100
Size	A1
Drawing Number	80816048-CI-0003
Revision	4